


DEPARTMENT OF VETERANS AFFAIRS CULPEPER NATIONAL CEMETERY




PROJECT #: 839-NRM14-0002

305 U.S. AVENUE CULPEPER, VA 22701

ADMINISTRATION BUILDING MODIFICATIONS

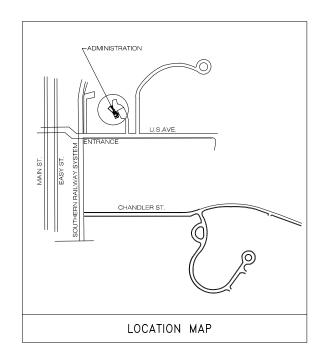

INDEX OF DRAWINGS					
SHEET NO.	SHEET TITLE				
X-001	COVER AND SHEET INDEX				
A-101	FLOOR PLAN & RCP				
A-102	ROOF PLAN & EXT. ELEVATIONS				
A-103	ENLARGED PLANS & DETAILS				
A-104	SECTIONS AND DETAILS				
M-101	HVAC PLAN				
E-101	ELECTRICAL PLAN				

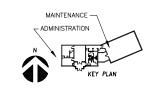



AMEC Environment & Infrastructure, 3200 TOWN POINT DR.
KENNES PROBECTO 16151-12-0118

OTTLA

NA CH

National Cemetery Administration

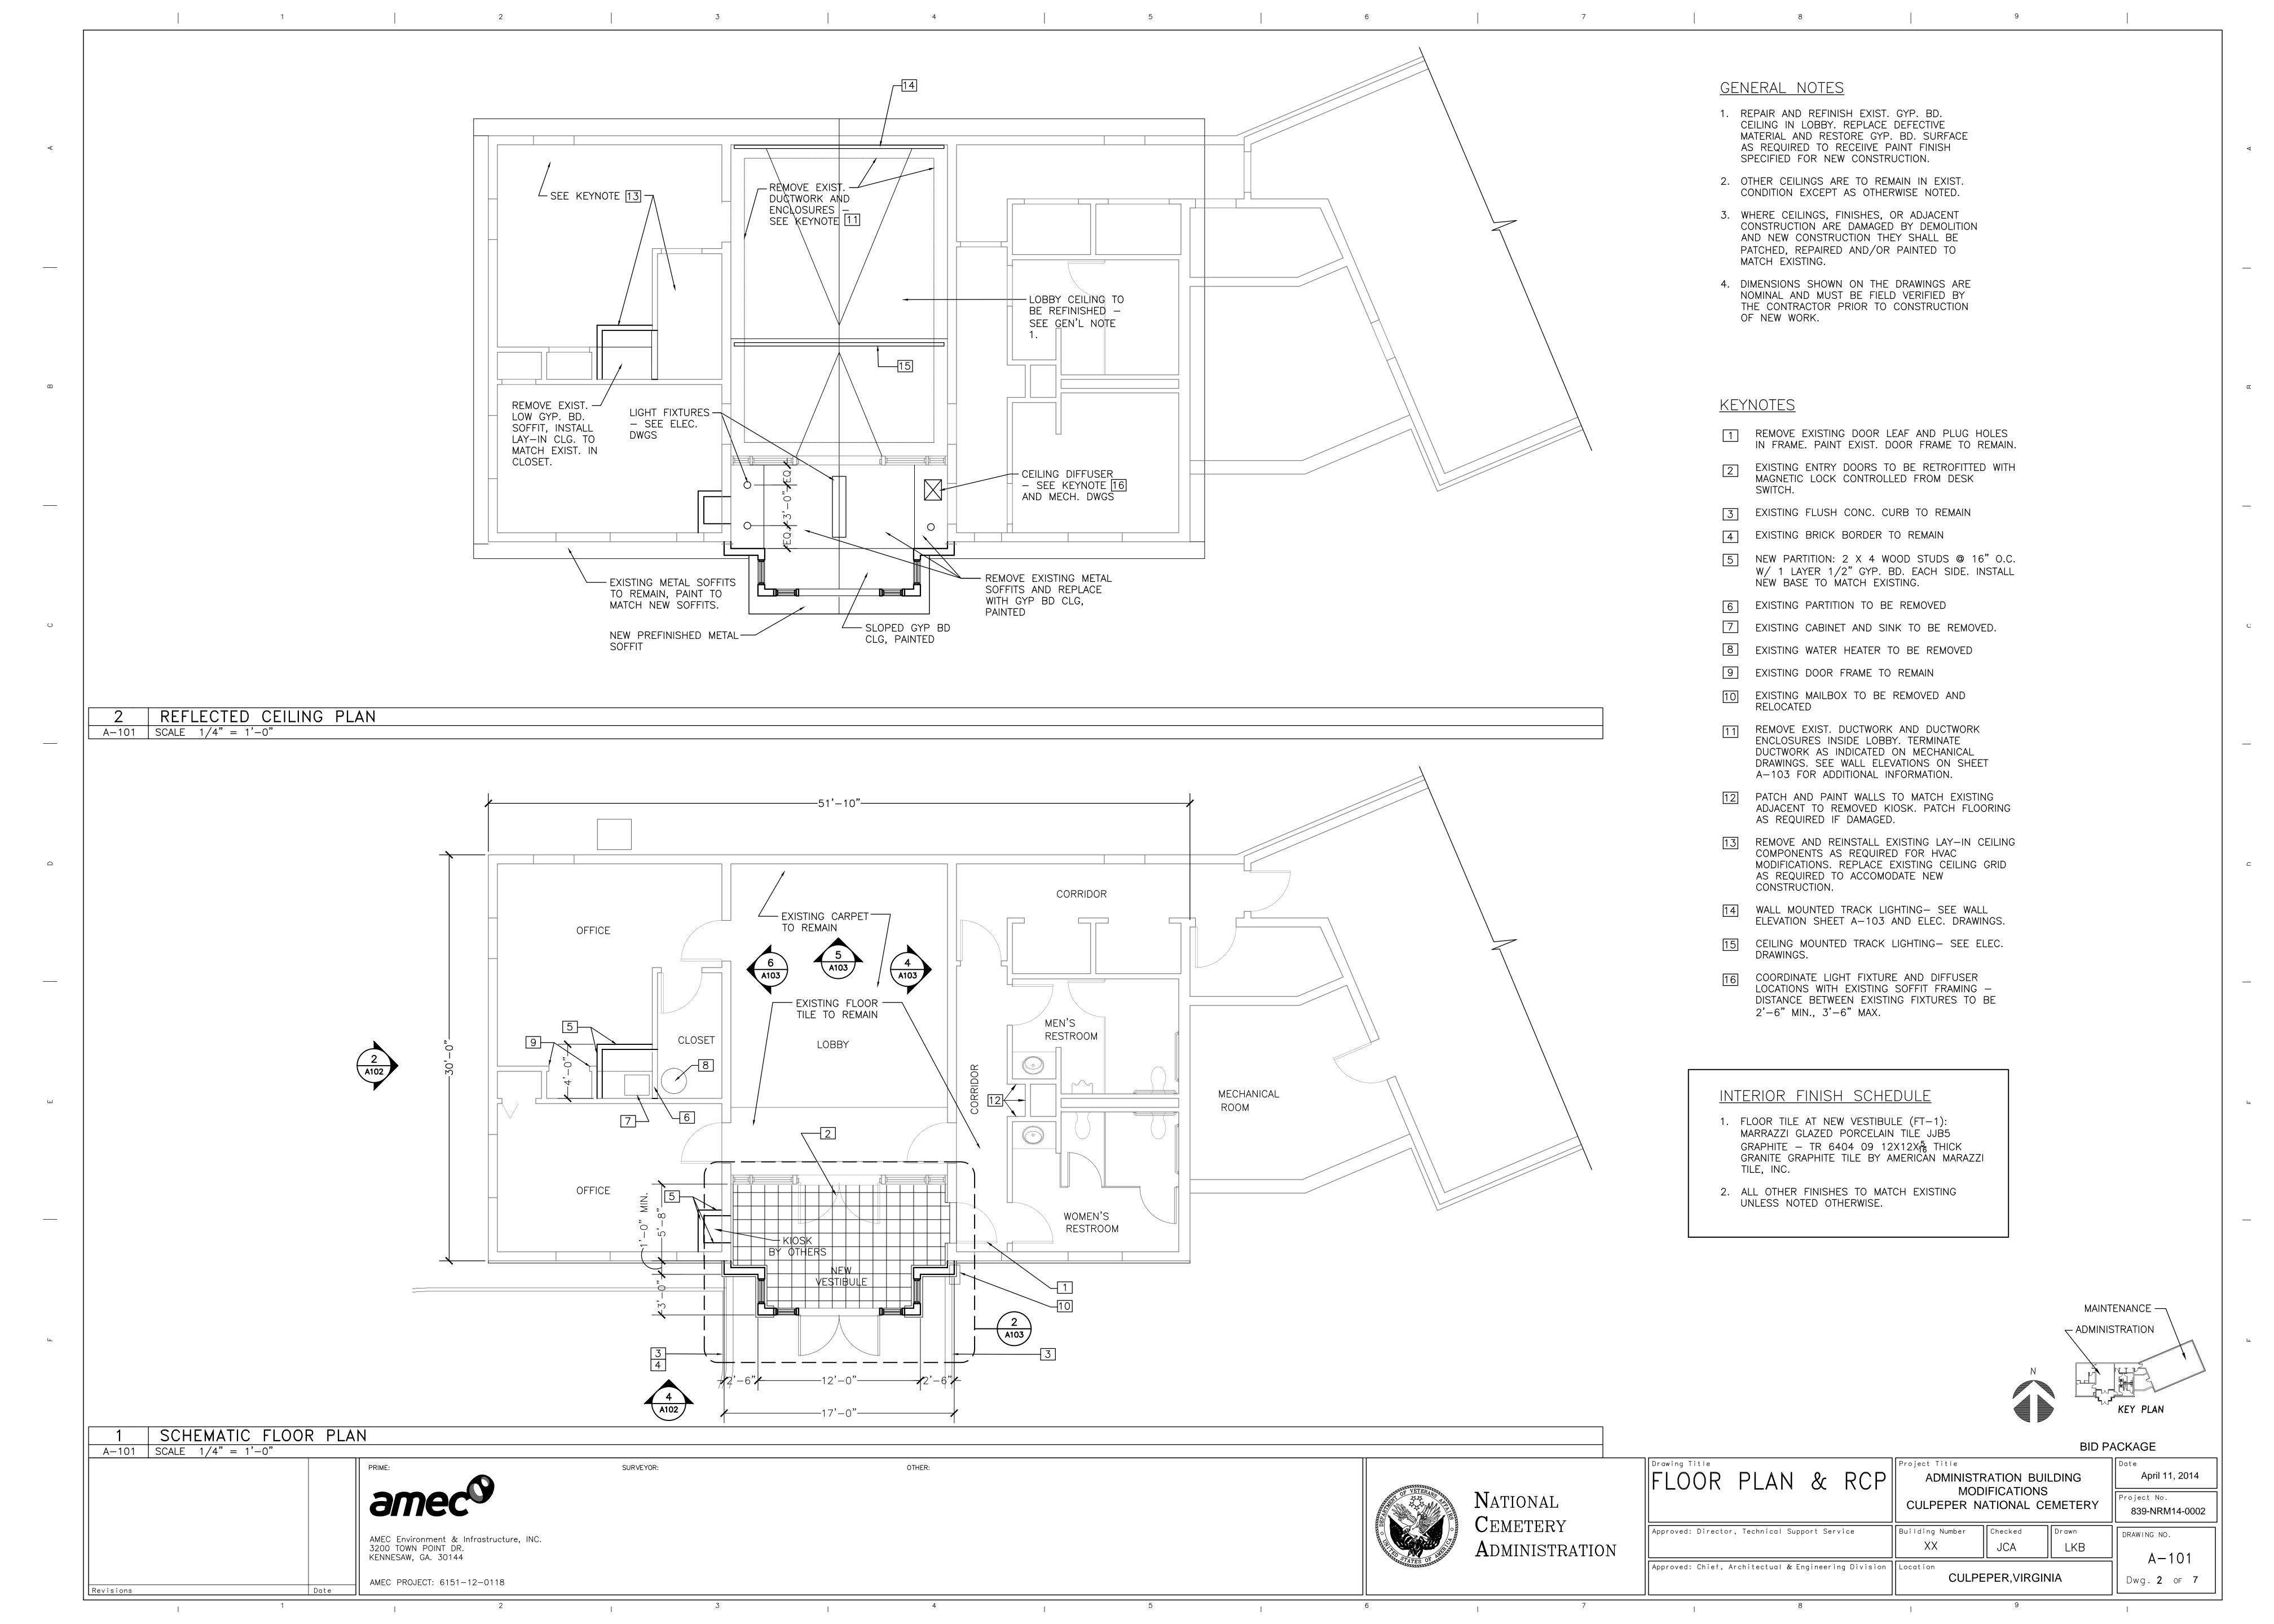

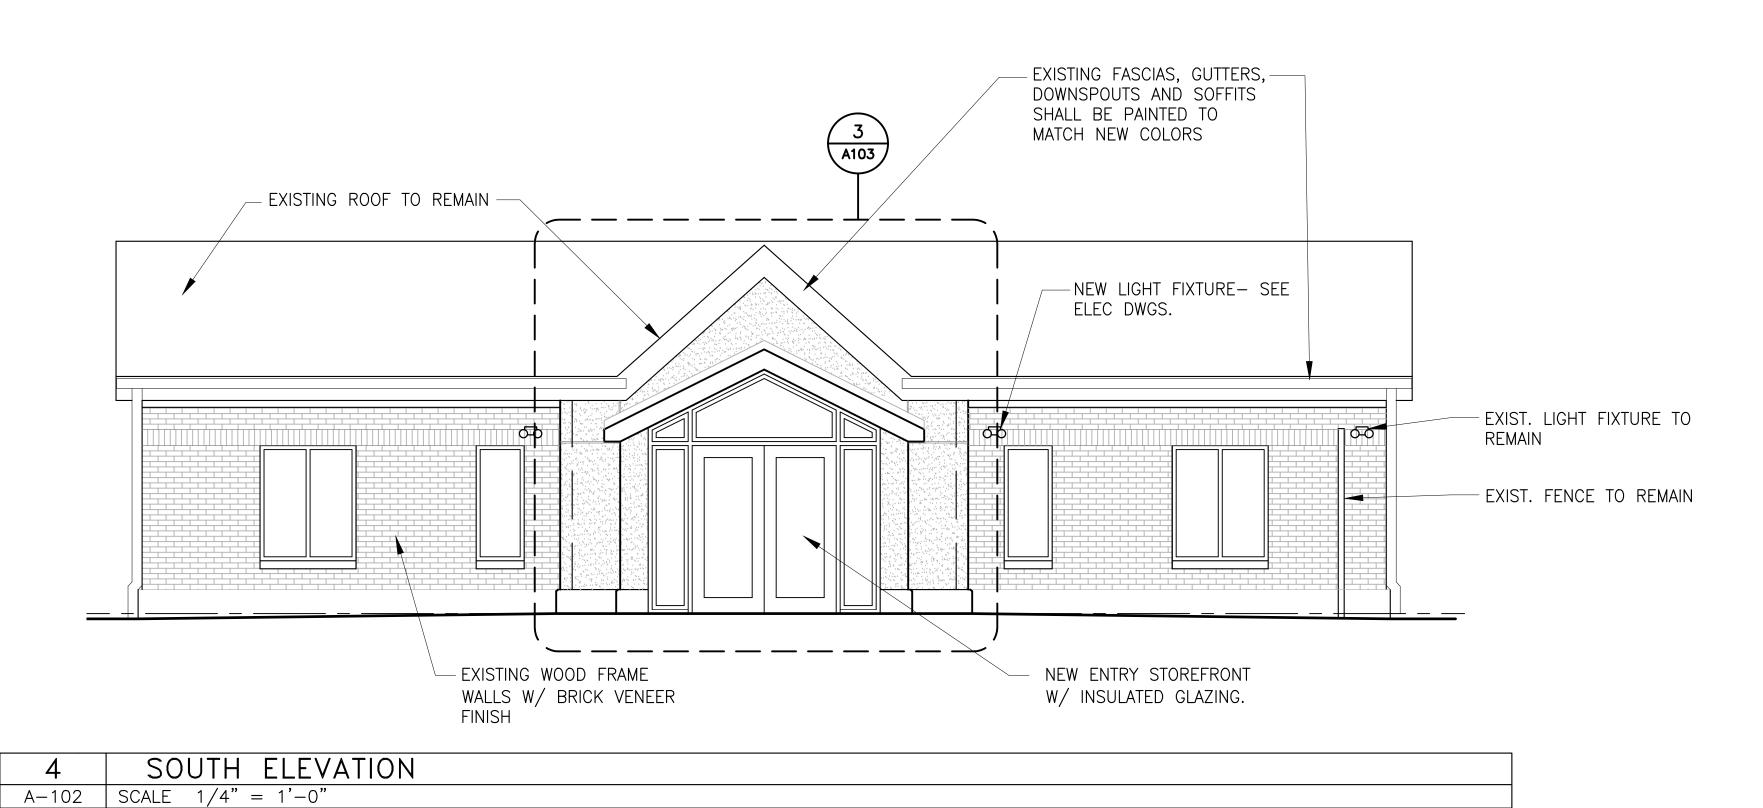

EXISTING FASCIAS, GUTTERS, DOWNSPOUTS AND SOFFITS SHALL BE PAINTED TO MATCH NEW COLORS — EXISTING ROOF TO REMAIN NEW ROOF W/ SHINGLES TO MATCH EXISTING TERMINATE NEW PAINT — POINT. MÁTCH EXISTING

COLOR CLEANLY AT THIS FIXED ALUMINUM WINDOW W/ CAST STONE SILL TO

2 WEST ELEVATION A-102 SCALE 1/4" = 1'-0"


r			
	DESIGNATION	LOCATION	PRODUCT
	PI-I	DOWNSPOUTS, GUTTERS, FASCIAS AND SOFFITS	BEHR ANTIQUE TIN UL260-21

PT-1	DOWNSPOUTS, GUTTERS, FASCIAS AND SOFFITS	BEHR ANTIQUE TIN UL260-21
PT-2	EXTERIOR WINDOW FRAMES	BEHR SUEDE GRAY UL-260-3
PT-3	STUCCO	BEHR ELASTOMERIC STUCCO PAINT SANDSTONE BEIGE MS-41

EXTERIOR PAINT SCHEDULE A-102 SCALE NTS

SURVEYOR:


OTHER:

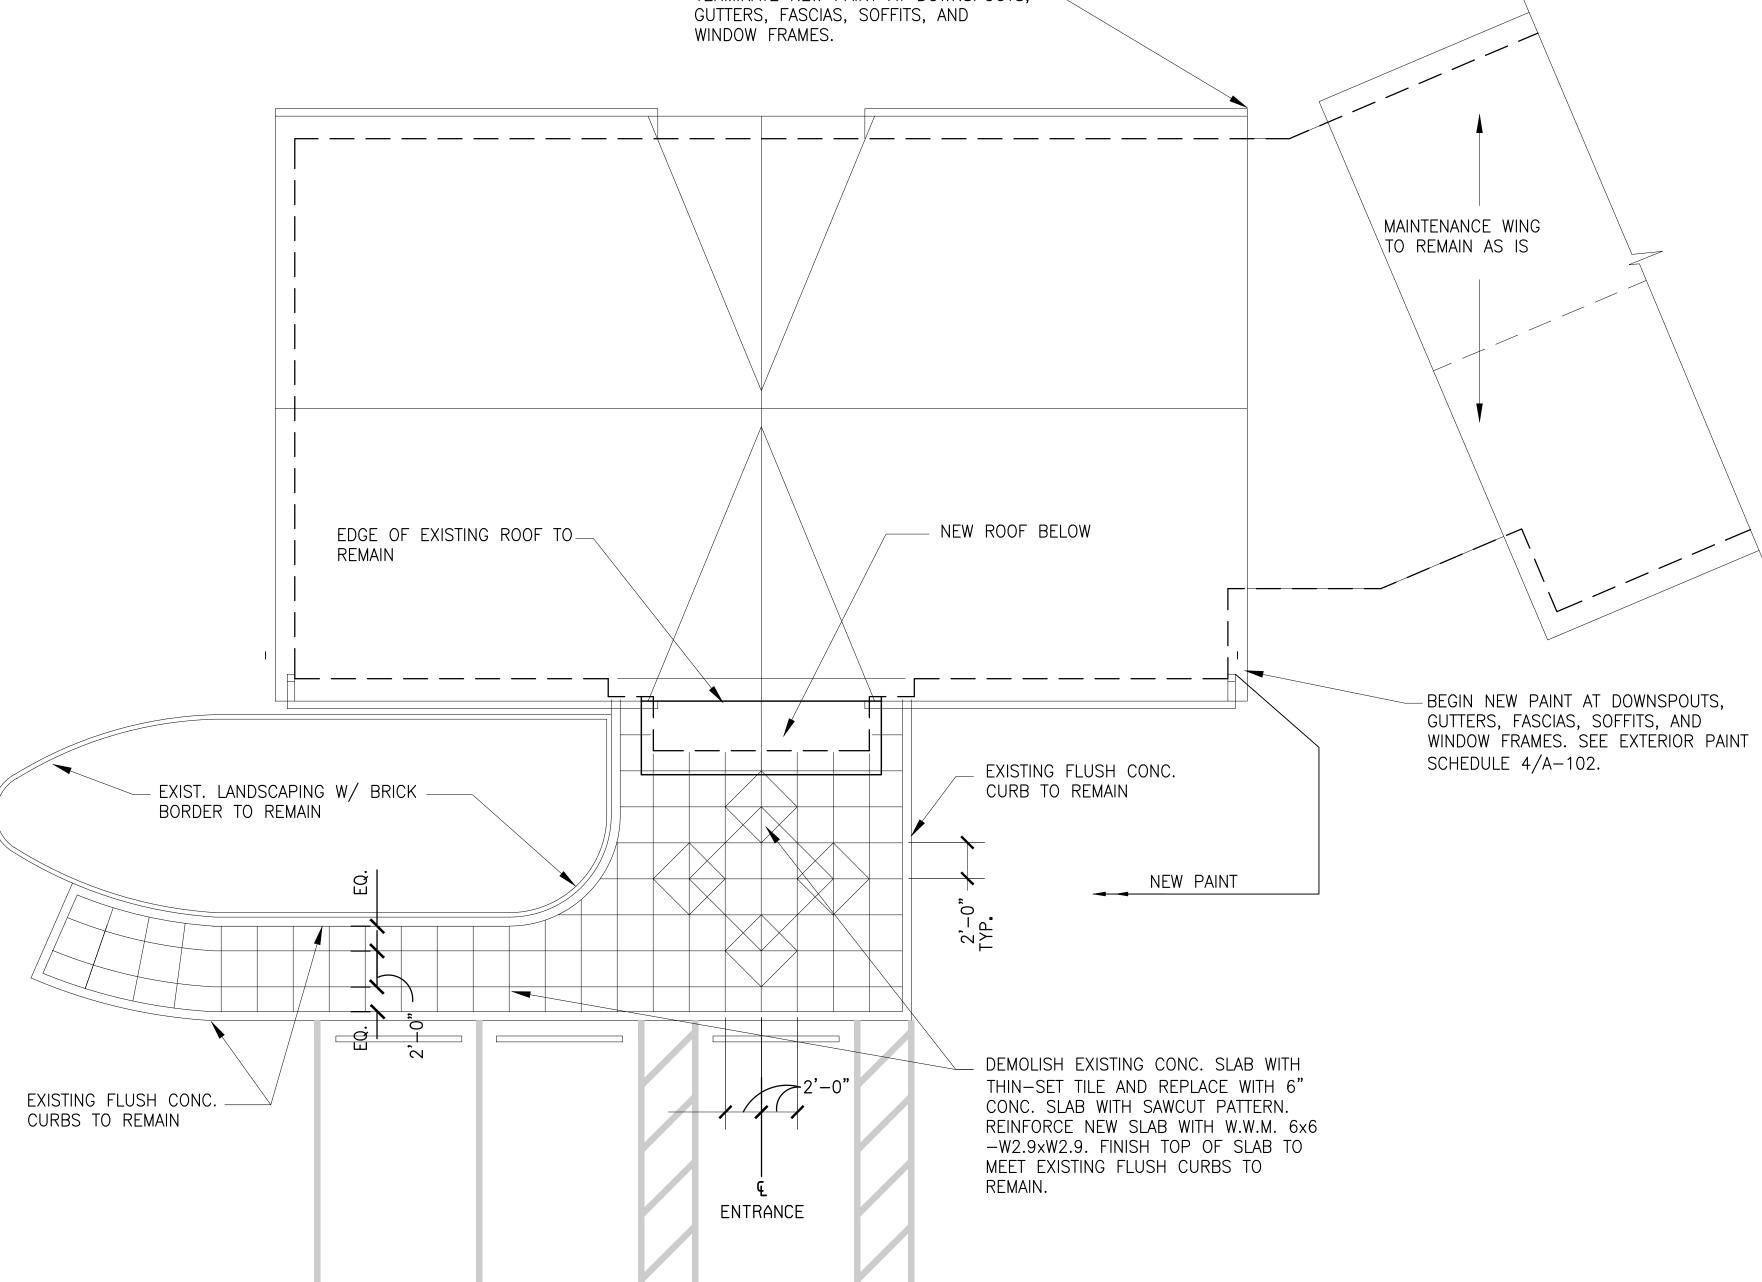

TERMINATE NEW PAINT AT DOWNSPOUTS,

3	ROOF PLAN/HARDSCAPE	PLAN
A-102	SCALE $3/16 = 1'-0"$	

SCALE:1/4"=1'

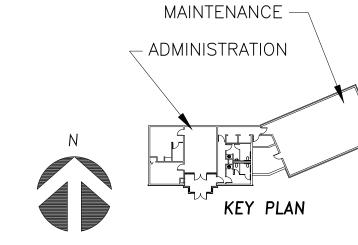



CEMETERY ADMINISTRATION

			BID PA	ACKAGE
ROOF PLAN & EXT.	Project Title ADMINISTE MOD	April 11, 2014		
ELEVATIONS	CULPEPER NA	Project No. 839-NRM14-0002		
Approved: Director, Technical Support Service	Building Number	Checked JCA	Drawn LKB	DRAWING NO. A-102
Approved: Chief, Architectual & Engineering Division	Location CULPE	PER,VIRGIN	NIA	Dwg. 3 of 7

AMEC Environment & Infrastructure, INC. 3200 TOWN POINT DR. KENNESAW, GA. 30144

AMEC PROJECT: 6151-12-0118

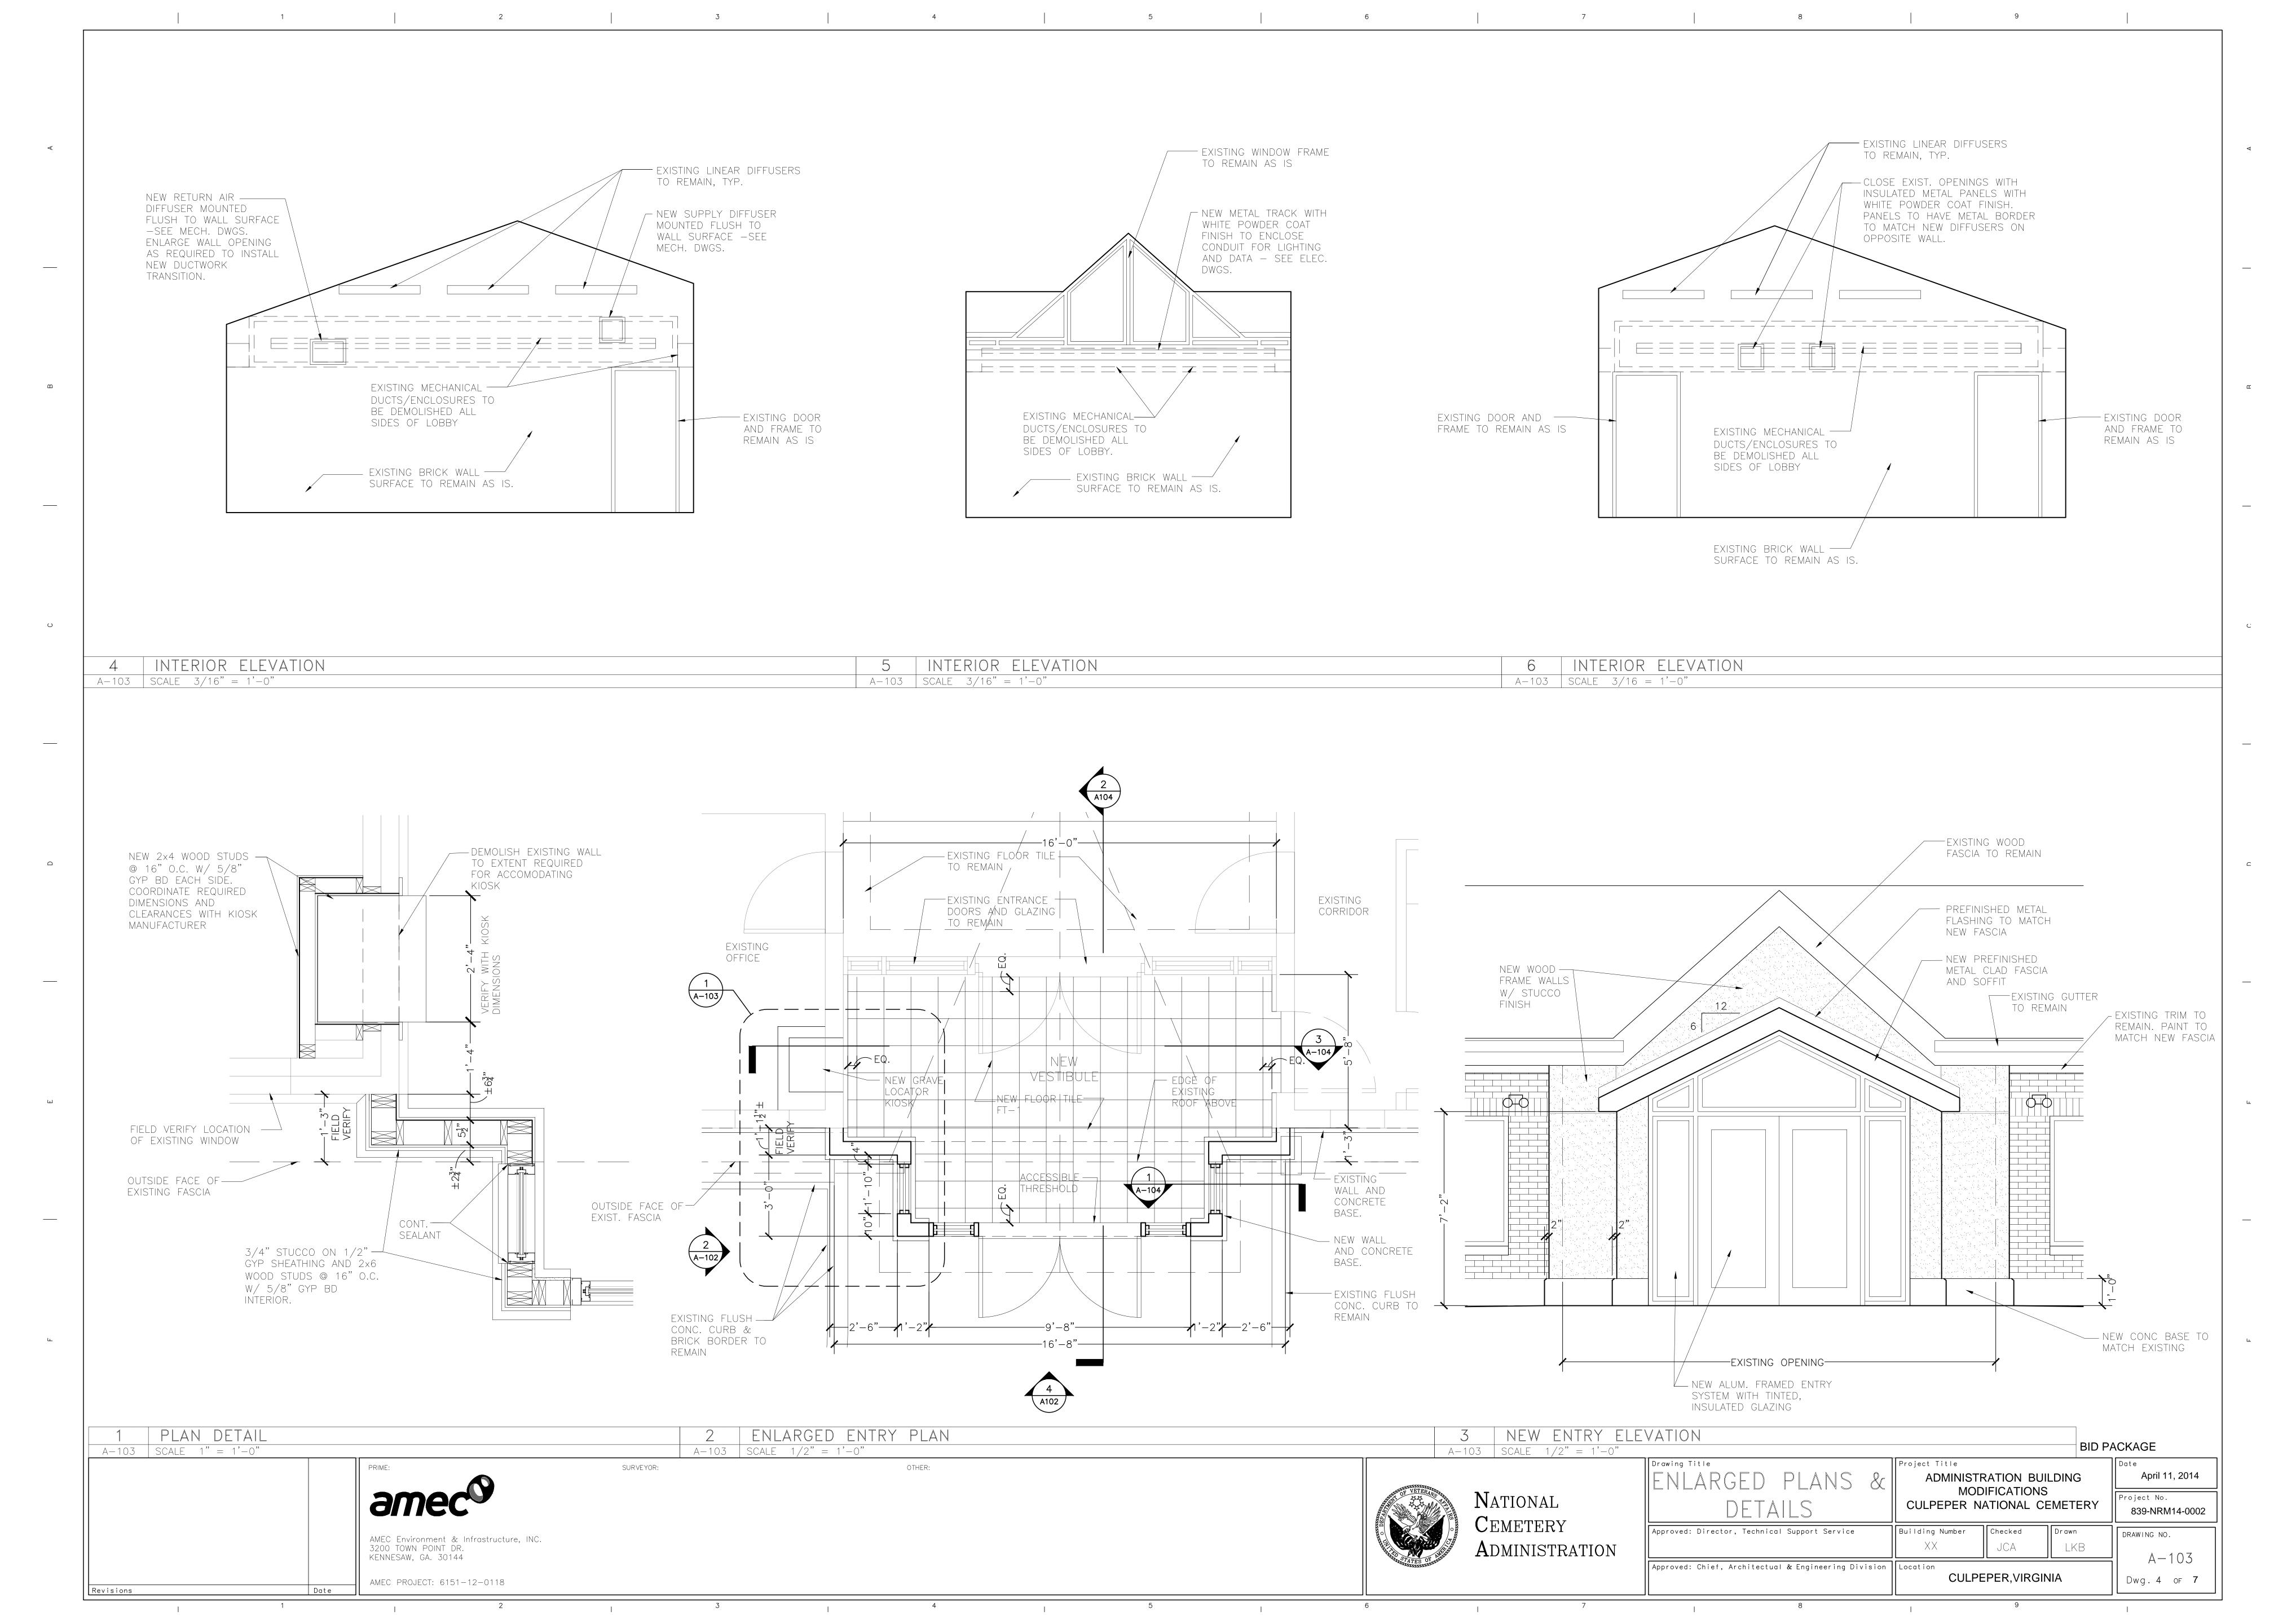

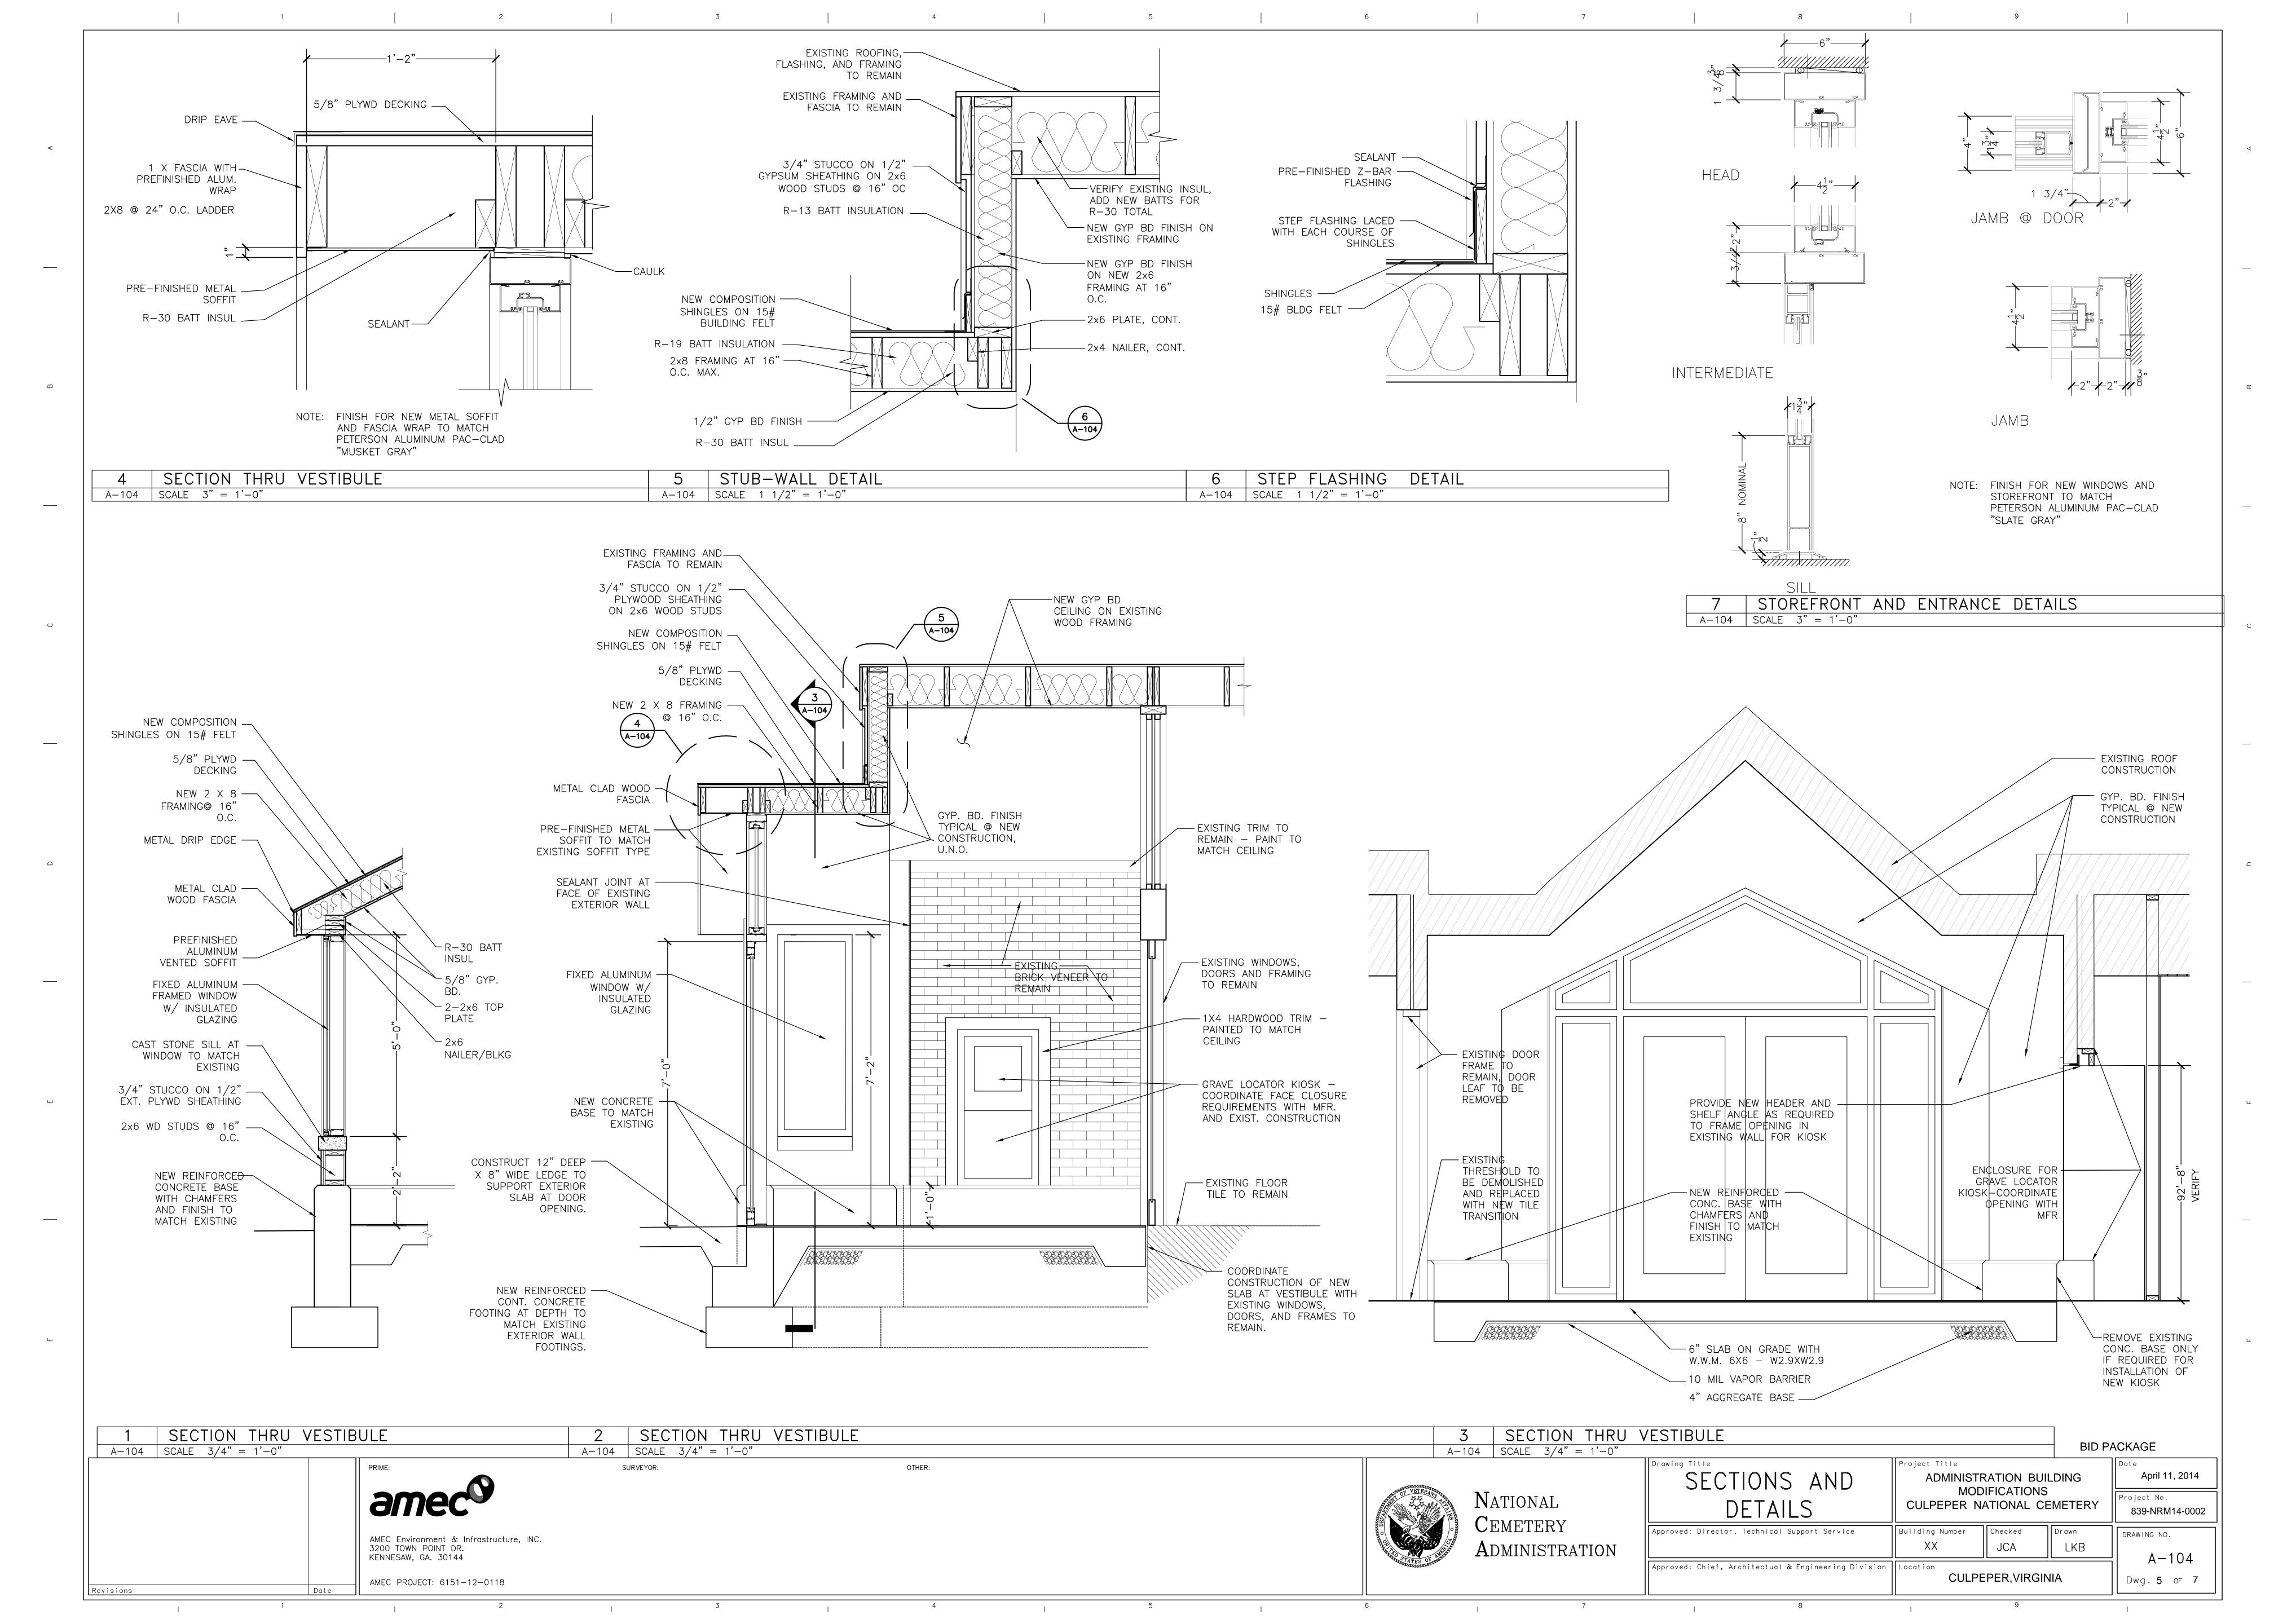

AIR HANDLER & CONDENSING UNIT SCHEDULE AIR HANDLER (INDOOR) CONDENSING UNIT (OUTDOOR) COOLING CONDITIONS <u>ELECTRICAL</u> <u>ELECTRICAL</u> BASIS OF DESIGN BASIS OF DESIGN AHRI RATED COOLING CAPACITY SENSIBLE CAPACITY SEER (MBH) AUX ELECTRIC HEATING COIL (kW) FAN E.S.P. VOLT/PH MARK MANUFACTURER <u>MANUFACTURER</u> <u>MODEL</u> <u>NOTES</u> 12345 0.50 CU-1 ARMSTRONG AIR 240/1 AHU-1 ARMSTRONG AIR BCS2M36V05NA1P 24 18 13 240/1 4SCU18LT124P

(1) CONTRACTOR TO PROVIDE CONDENSATE PUMP IF REQUIRED


2 CONTRACTOR TO PROVIDE LONG-LINE SET IF REQUIRED

(3) CONTRACTOR TO PROVIDE TRANSFORMER IF REQUIRED

(4) INDOOR EXPANSION VALVE: A4TXV01

5) INTERLOCK AHU-1 AND CU-1 TO OPERATE PER MANUFACTURER'S INSTRUCTIONS.

	AIR DISTRIBUTION SCHEDULE						
MARK	BASIS OF DESIGN MANUFACTURER	MODEL	FLOW (CFM)	NECK (IN)	FACE (IN)	BORDER	<u>FINISH</u>
S-1	PRICE	520D	615	12x12	HORIZONTAL FRONT BLADES	F	WHITE POWDER COAT
S-2	PRICE	SMD	350	12x9	1B	TYPE 1 SURFACE MOUNT	WHITE POWDER COAT
S-3	PRICE	SCDA	350	10 DIA.	24x24 ADJUSTABLE SQUARE CONE	LAY-IN	WHITE POWDER COAT
R-1	PRICE	530		18x12		F	WHITE POWDER COAT
R-2	PRICE	530		12x12		F	WHITE POWDER COAT

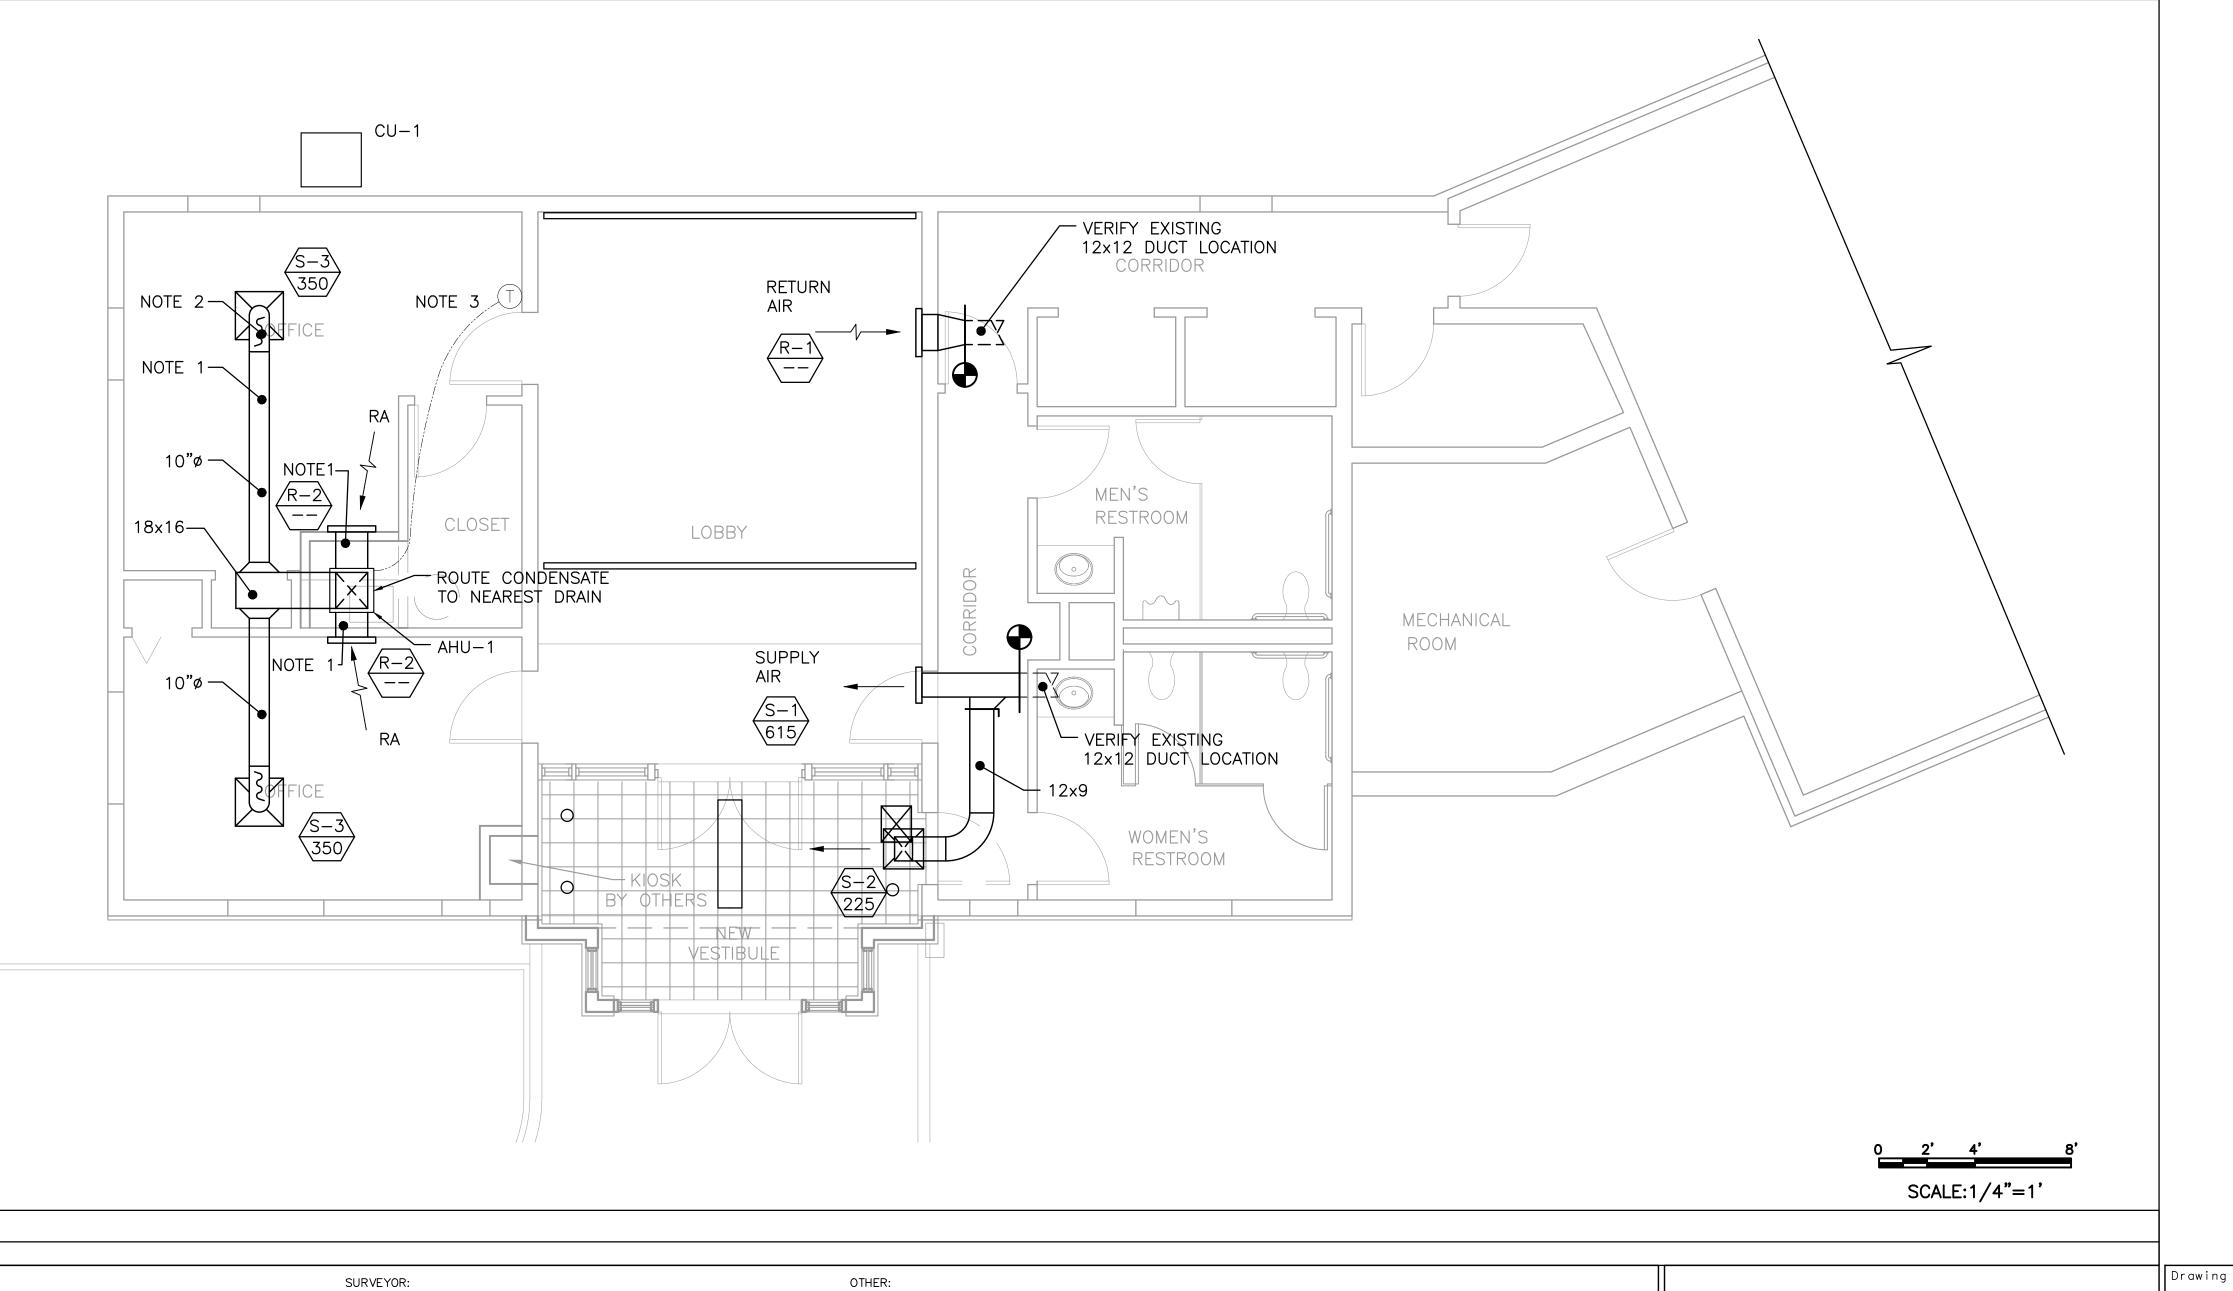

MAINTENANCE — ADMINISTRATION

KEY PLAN

BID PACKAGE

1 SCHEMATIC HVAC FLOOR PLAN
M-101 SCALE 1/4" = 1'-0"

TARGET INDICATES NEW DUCT CONNECTION

- MARK (SEE AIR DISTRIBUTION SCHEDULE)

NOTE 1:

1-INCH

NOTE 2:

<u>SYMBOLS</u>

THERMOSTAT

Revisions

PROVIDE INSULATED (2-INCH THICK FIBERGLASS

BATT WITH FSK JACKET) GALVANIZED SHEETMETAL

PROVIDE DOUBLE-WALLED, INSULATED FLEXIBLE

DUCTWORK. SUPPORT ACCORDING TO SMACNA

STANDARDS. PRESSURE CLASS: 1-INCH

PROVIDE PROGRAMMABLE THERMOSTAT PER

MANUFACTURER'S RECOMMENDATIONS.
SUITABLE FOR INSTALLED EQUIPMENT.
MINIMUM FEATURES TO INCLUDE NIGHT
SETBACK AND HOLIDAY SCHEDULE.

TO EXISTING DUCTWORK

DUCTWORK. CONSTRUCT AND SUPPORT ACCORDING TO SMACNA STANDARDS. PRESSURE CLASS:

AMEC Environment & Infrastructure, INC. 3200 TOWN POINT DR. KENNESAW, GA. 30144

AMEC PROJECT: 6151-12-0118

NA CHANGE AND A

National Cemetery Administration Project Title

ADMINISTRATION BUILDING

MODIFICATIONS

CULPEPER NATIONAL CEMETERY

Approved: Director, Technical Support Service

XX

DPA

MJL

CULPEPER, VIRGINIA


Approved: Chief, Architectual & Engineering Division | Location

April 11, 2014

Project No.
839-NRM14-0002

DRAWING NO.
M-101

Dwg. 6 OF 7

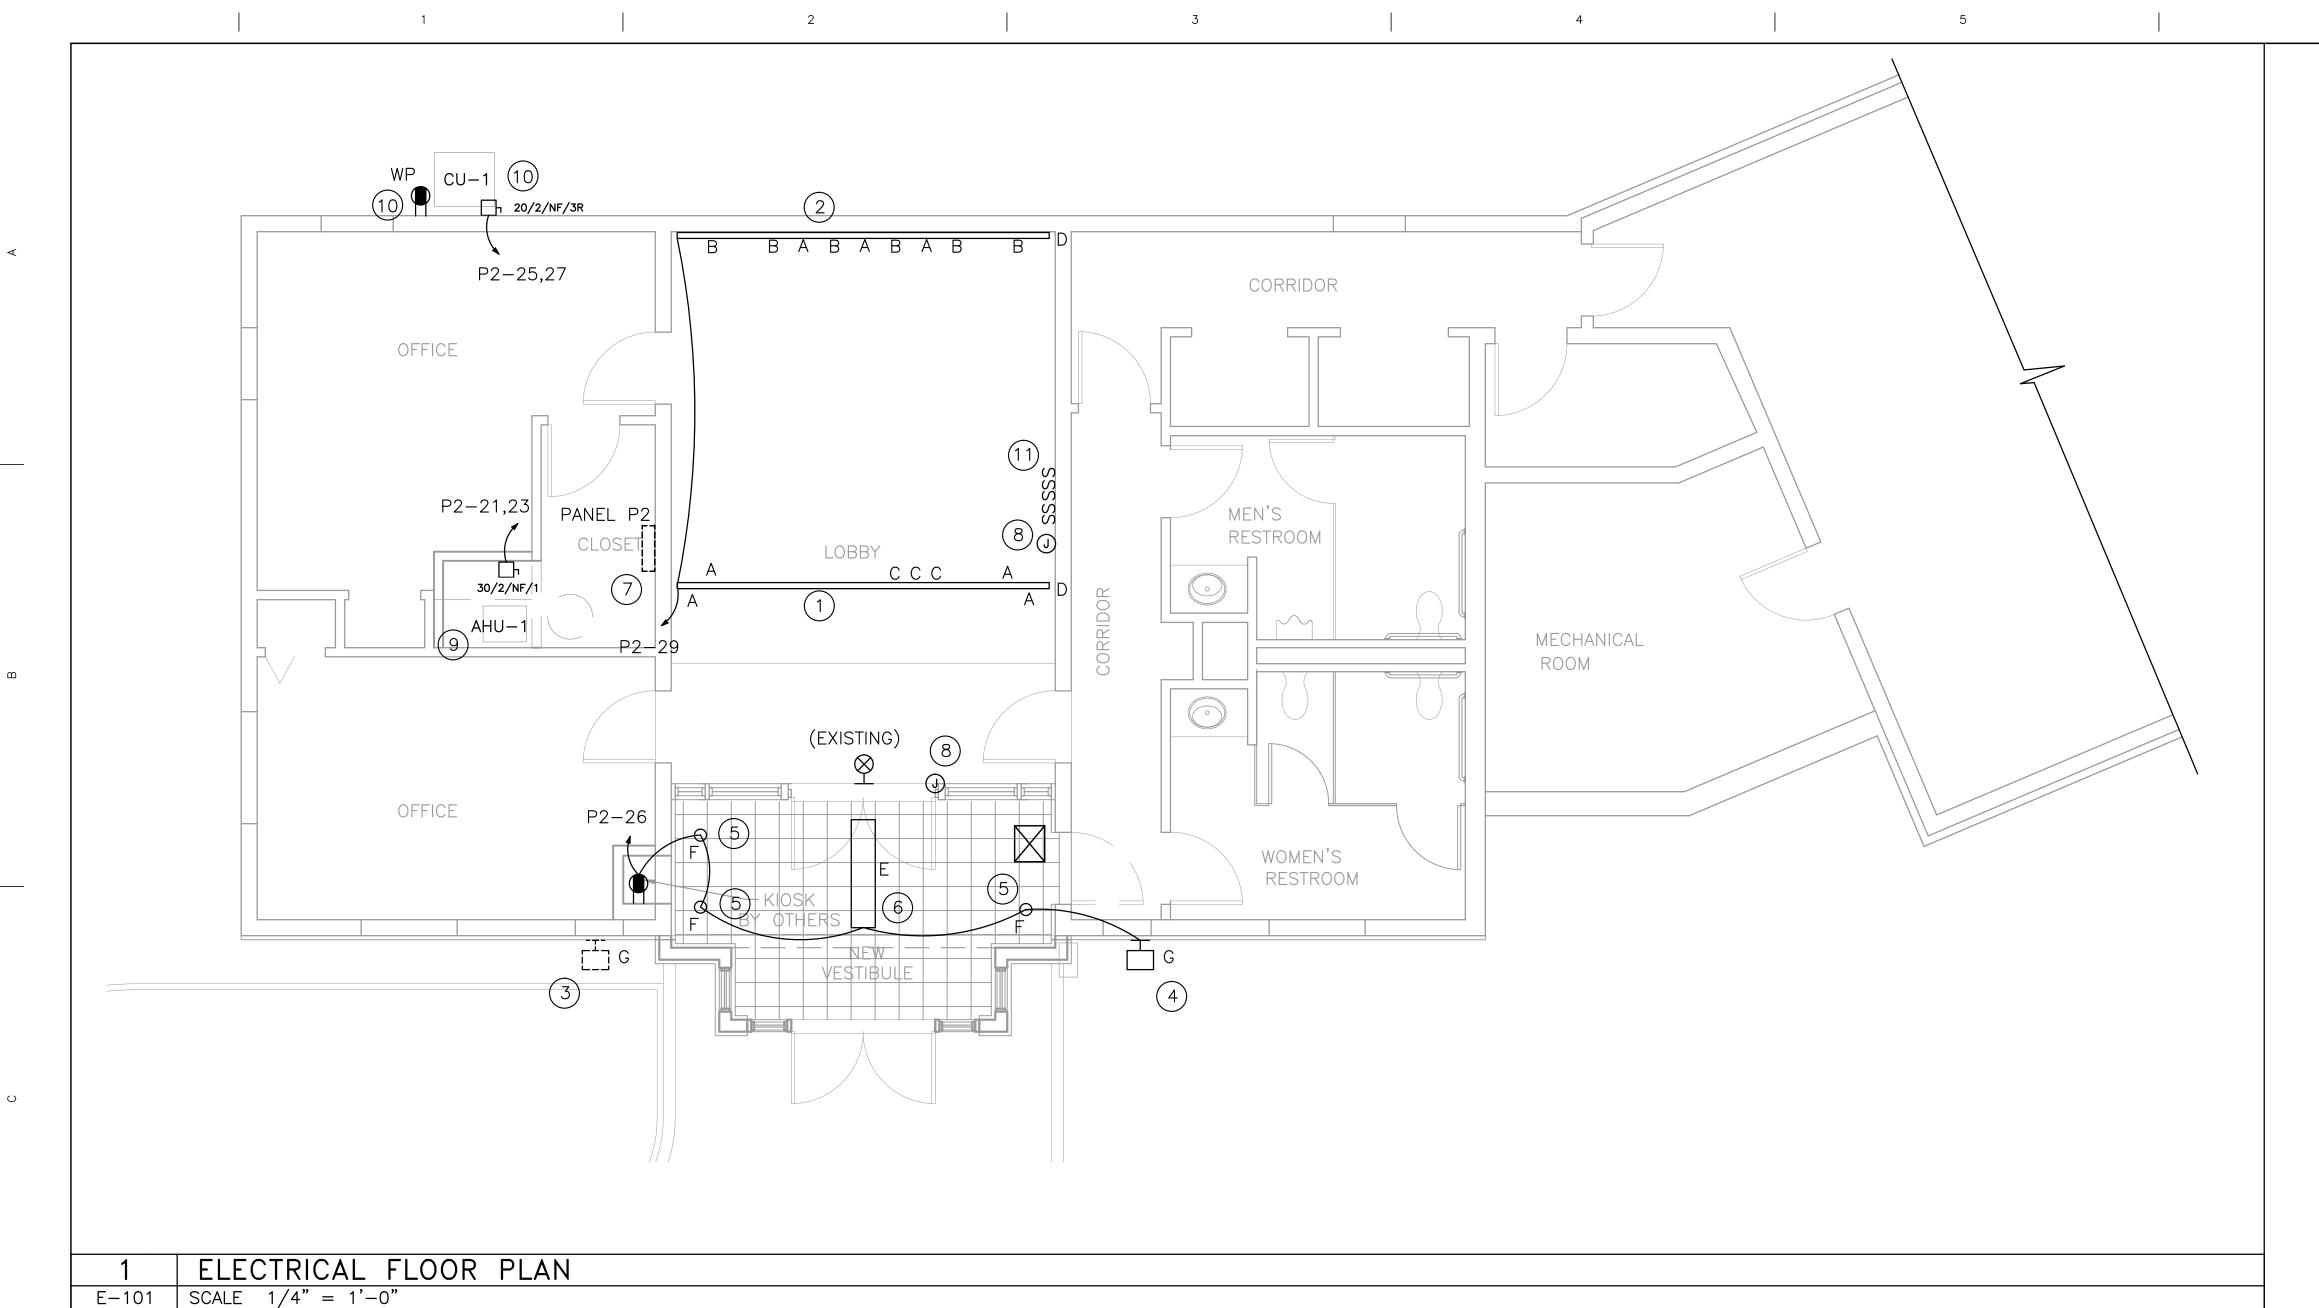

7 RM 100 LIGHTS AND RECS(LOSSY) 8 REC. NORTH WALL RM 100 9 REHEAT COIL RM 101 10 REC NORTH WALL RM 100
11 COVE LTS RM 100 12 REC EAST WALL RM 100
13 KITCH AND ELECTRIC RM LTS 14 FLOOR PLUG RM 104 15 RECS COUNTER LTS UNDER CABINET16 SPARE MADE IN U.S.A. SQUARE D COMPANY



EXISTING ELECTRICAL PANEL P2 E-101 SCALE 1/4" = 1'-0"

Revisions

<u>LEGEND</u>

NEW 9.5"Wx48"L LIGHT FIXTURE, TYPE INDICATED

NEW TRACK LIGHT FIXTURE, TYPE INDICATED

NEW EXTERIOR WALL MOUNTED DUAL FLOOD LIGHT

EXISTING EXTERIOR WALL MOUNTED DUAL FLOOD

LIGHT FIXTURE.

EXISTING EXIT LIGHT TO REMAIN NEW GFCI DUPLEX RECEPTACLE

NEW JUNCTION BOX

FIXTURE.

LONG CROSSMARK INDICATES PHASE, SHORT CROSSMARK INDICATES NEUTRAL, GROUND NOT

NEW HOME RUN (ONE ARROW PER CIRCUIT)

EXISTING SINGLE POLE LIGHT SWITCH TO REMIAN NEW THREE WAY TOGGLE LIGHT SWITCH

EXISTING PANEL TO REMAIN

NON FUSED DISCONNECT SWITCH, SIZE/POLES/FUSE/ENCLOSURE (NEMA) TYPE, 30/1/NF/3R

MOUNTING HEIGHT = 36" ABOVE FINISH FLOOR

KEY NOTES:

- NEW CEILING MOUNTED TRACK TYPE "D". INSTALL LIGHT FIXTURES AS INDICATED. SEE LIGHTING FIXTURE SCHEDULE ON THIS SHEET.
- 2 NEW WALL MOUNTED TRACK TYPE "D". INSTALL LIGHT FIXTURES AS INDICATED. SEE LIGHTING FIXTURE SCHEDULE ON THIS SHEET.
- REPLACE EXISTING EXTERIOR WALL MOUNTED DUAL FLOOD LIGHT FIXTURE WITH NEW TYPE "G" FIXTURE. RECONNECT TO EXISTING CIRCUIT. SEE LIGHTING FIXTURE SCHEDULE ON THIS SHEET.
- (4) NEW EXTERIOR WALL MOUNTED DUAL FLOOD LIGHT FIXTURE TYPE "G". NEW FIXTURE TO MATCH EXISTING FIXTURE IN COLOR AND MATERIAL. SEE LIGHTING FIXTURE SCHEDULE ON THIS SHEET.
- NEW CEILING MOUNTED RECESSED CAN LIGHT FIXTURE TYPE "F". SEE LIGHTING FIXTURE SCHEDULE ON THIS SHEET.
- 6 NEW CABLE HUNG FLUORESCENT LIGHT FIXTURE TYPE "E". SEE LIGHTING FIXTURE SCHEDULE ON THIS SHEET.
- (7) VERIFY LOCATION OF EXISTING PANEL "P2". VERIFY THAT AVAILABLE SPACE EXISTS IN PANEL P2. IF THE CIRCUIT IS AVAILABLE, PROVIDE NEW CIRCUIT BREAKERS AS INDICATED. VOLTAGE DROP SHOULD NOT BE MORE THAN 3%.
- PROVIDE NEW SECURITY MAGNETIC DOOR LATCH WITH PUSH BUTTON RELEASE. COORDINATE LOCATION OF RELEASE BUTTON WITH OWNER. INSTALL ACCESS CARD READER ADJACENT TO DOOR IN VESTIBULE AND AN EXIT PUSH BUTTON ADJACENT TO DOOR IN LOBBY. COORDINATE EXACT LOCATION WITH OWNER.
- 9 PROVIDE NEW 240V DISCONNECT (MIN 30A) FOR AHU-1. CONNECT CIRCUIT BACK TO EXISTING PANEL P2 AND PROVIDE NEW 30A DOUBLE POLE HACR TYPE CIRCUIT BREAKER.
- (10) PROVIDE NEW 240V OUTDOOR RATED DISCONNECT (MIN 20A) FOR CU-1. CONNECT CIRCUIT BACK TO EXISTING PANEL P2 AND PROVIDE NEW 20A DOUBLE POLE HACR TYPE CIRCUIT BREAKER. ADD NEW GFCI RECEPTACLE IN WEATHER PROOF ENCLOSURE AND CONNECT TO NEAREST 120V CIRCUIT.
- (11) COORDINATE LOCATION AND CIRCUITING OF NEW LOBBY AND VESTIBULE LIGHT SWITCHES WITH OWNER. PROVIDE A SEPARATE SWITCH FOR EACH TYPE OF FIXTURE "A", "B", "C", "E", AND "F".

GENERAL NOTES:

- 1. COORDINATE LOCATIONS OF NEW LIGHTING FIXTURES WITH ARCHITECTURAL DRAWINGS.
- 2. ALL EXPOSED INTERIOR CONDUITS SHALL BE EMT.
- 3. CONTRACTOR SHALL USE CONDUCTOR INSULATION TYPE "THWN" FOR ALL BRANCH CIRCUITS.
- 4. ALL ELECTRICAL WORK SHALL BE IN ACCORDANCE WITH THE LATEST APPROVED NEC EDITION, AND LOCAL CODES AND REGULATIONS.
- 5. A GREEN EQUIPMENT GROUNDING CONDUCTOR INSULATED OR BARE WIRE SHALL BE INCLUDED IN EACH CABLE OR CONDUIT AND ATTACHED TO THE FRAME OF ENCLOSURE.
- 6. MINIMUM TRADE CONDUIT SIZE SHALL BE 3/4". CONDUITS CONTAINING MORE THAN THREE CURRENT CARRYING CONDUCTORS SHALL BE ADJUSTED ACCORDING TO NEC CODE (TABLE 310.15(B)(2)(a)).
- 7. ANY NEW CIRCUIT BREAKER TO BE INSTALLED IN AN EXISTING PANEL SHALL HAVE AIC RATING NOT LESS THAN THE WITHSTANDING RATING OF THE EXISTING PANEL.
- 8. FIELD VERIFY ALL EXISTING INFORMATION SHOWN ON THIS SHEET PRIOR TO COMMENCING WORK.
- 9. ALL MATERIAL FURNISHED BY THE CONTRACTOR SHALL BE NEW AND UL LISTED. MATERIALS SHALL BE SUBJECT TO TEST, INSPECTION AND APPROVAL BY THE OWNER OR THE ENGINEERS.
- 10. UPDATE EXISTING DIRECTORIES FOR EXISTING PANELBOARDS WHERE NEW CIRCUITS ARE ADDED.

	LIGHTING FIXTURE SCHEDULE						
TYPE	LAMPS	MOUNTING					
А	75W PAR-30	120	ROUND BACK CYLINDER, 4.5" DIAMETER, WHITE, PRESCOLITE AKTRCP30	TRACK MOUNTED			
В	50W PAR-20	120	LINE FORM STYLE, WHITE, PRESCOLITE AKTLF20	TRACK MOUNTED			
С	60W PAR-16	120	ROUND BACK CYLINDER, 2.75" DIAMETER, WHITE, PRESCOLITE AKTRCP16	TRACK MOUNTED			
D		120	TWO CIRCUIT TRACK, WHITE, 12' LENGTH, PRESCOLITE AKT12	CEILING/WALL FLUSH			
E	1-F28T5 (LAMPS & BALLAST: 65W)	120	SINGLE ROW 4' LONG FLUORESCENT INDIRECT LUMINARIE, 9.5"WIDTH, DIE CAST ALUMINUM WITH AIRCRAFT CABLE SUSPENSION. MODEL# ALERA CV-4-1T5-S-CM-48-EP-U-MW-HRF	PENDANT MOUNTED.			
F	LP32T35K	120	6" VERTICAL TRIPLE TUBE LENSED DOWNLIGHT PRESCOLITE LF6CFV-32-EB	CEILING RECESSED			
G	2X 150W MAX EACH	120	TWIN PAR HOLDER, DUSK TO DAWN LITHONIA LIGHTING OFTH300PR-120-P-BZ	WALL FLUSH			

ABBREVIATIONS:

THREE WIRE FOUR WIRE ARCHITECT/ENGINEER ALTERNATING CURRENT AMP FRAME ABOVE FINISHED FLOOR

FULL LOAD AMPS

JUNCTION BOX

AMPERE INTERRUPTING CAPACITY BUILDING **BREAKER**

CONDUIT CKT CIRCUIT COPPER DEMOLITION **DRAWINGS EMERGENCY**

FEET GROUND HORSEPOWER HEIGHT HERTZ

ΚW KILOWATT NATIONAL ELECTRICAL CODE NATIONAL ELECTRICAL MANUFACTURERS ASSOCIATION

NFPA NATIONAL FIRE PROTECTION ASSOCIATION

NOT TO SCALE POLE PHASE

RGS RIGID GALVANIZED STEEL RM ROOM SPECIFICATION

SWITCH TYPICAL UNDERWRITERS LABORATORY


WEATHER PROOF

MAINTENANCE — - ADMINISTRATION

BID PACKAGE

April 11, 2014

E - 101

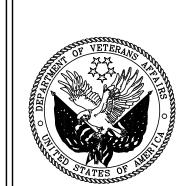

 ${f N}$ ational CEMETERY **A**DMINISTRATION

ELECTRICAL PLAN ADMINISTRATION BUILDING MODIFICATIONS roject No. CULPEPER NATIONAL CEMETERY 839-NRM14-0002 Approved: Director, Technical Support Service Building Number Checked DRAWING NO. XX Approved: Chief, Architectual & Engineering Division | Location CULPEPER, VIRGINIA Dwg. **7** of **7**

KENNESAW, GA. 30144

AMEC Environment & Infrastructure, INC. 3200 TOWN POINT DR.

SURVEYOR:

OTHER:

AMEC PROJECT: 6151-12-0118